

Patio

Site Area: ???m2

Site Coverage: 00.0%

Approximate height and positions of retaining walls and fences

site conditions at the builders discretion.

shown. The heights and positions may vary from the plans due to

4,500

To Wall

0.235 FF

12.9 m²

Lot ???

???m² (Approx)

Vacant

30.00m

Proposed

Residence

Building Platform Approx 0.000 FGL / 310 FFL

30.00m

♦ NORTH POINT WARNING

The user should ensure this is suitable for their purpose

G Developments Turn Key Package

XX.Xm² - Exposed aggregate conc. driveway (4.0m wide at boundary), porch Alfresco & path to

As constructed drawings required to determine final location of services

(SWR HC)

Approx. Position of sewer 'house connection'. Plumber to confirm on site prior to commencement of excavation

Natural gas available on site. Provide meter box for gas meter. Locating gas main connection point and connection from gas main to house by g developments

Best practice procedures for erosion & sediment control as outlined by Council regulations to be adhered to



Existing tree to be removed



Trees within the zone of influence to be Suitable precautions should be taken

such as additional piering

No boundary survey has been undertaken.

Services shown are indicative only. Positions are based on surface indicators located during field survey. Confirmation of the exact position should be made to the relevant authorities prior to any excavation work. Other services may exist which are not shown.

Levels are based on assumed datum.

Contour interval 0.2m.

Fence Legend

1800 high timber pailing fence

Approx. Total length of fence = XX.Xm + Gate

Approx. Length of fence

FENCE XX.Xm

The deposited plan for the subject lot was not registered with the department of lands at the time of the survey. The dimensions and orientation of the subject lot have been taken from a draft deposited plan and pegs found on site and is subject to change upon registration of the

. The subject lot boundaries will require re-surveying after the registration of the lot dimensions and bearings.

Un-registered Boundary Line

RETAINING WALL LEGEND

Timber retaining wall

Masonry Block

Approx. Height of retaining walls (mm)

Address: P.O. BOX 600 PARADISE POINT, 4216

ACN: 116332220

ABN: 77116332220 QBSA: 1086689

"Building a Shared Vision

"2018 Design Range" Mr & Mrs #Client Family Name Coogee 176 **Traditional Facade** A XX.XX.2018 Pre-Construction Copy Garage to RHS NSIONS TO BE READ IN PREFERENCE TO SCALIN

Siteworks / Notes - Subject to full covenant approval by client prior to council lodgement Cut Batter: 1:3 / Fill Batter: 1:3 NO HEAVY COMPACTION - G Developments takes no responsibility for damage to existing **OVER SERVICES** access way, retaining walls or fences. Location of yard gullies are indicative only and **Engineers Wind**

5,460

To Garage

54.6 m²

Garage

1,000 To Walk

0.235 FFL

Subject to local government authority energy efficiency requirements may be moved at the discretion of the builder on Classification: ?? site to suit site conditions

Site Address

Lot ???

Road

Estate Name

LGA: Council

SUBURB QLD 4???

DP: Unregistered

Road

Cut:-

Council

Proposed driveway profile

000mm Fill:-000mm Pad R.L:-0.000m Main Slab R.L:-310m Garage Slab R.L:-0.235m Critical AHD Pad Level Building platform height shown is approx.

Site Plan Plot Date: 29/6/2018 Checked Date: Scale: 1:200

SITEWORKS

Only & may vary on site due to site

02 405###



Communications Pre-wired

Note:


Provide security screens to all openable windows & sliding glass doors

Provide full ht. Masonry articulation as per engineers report


Note:

450mm Eave U.N.O.



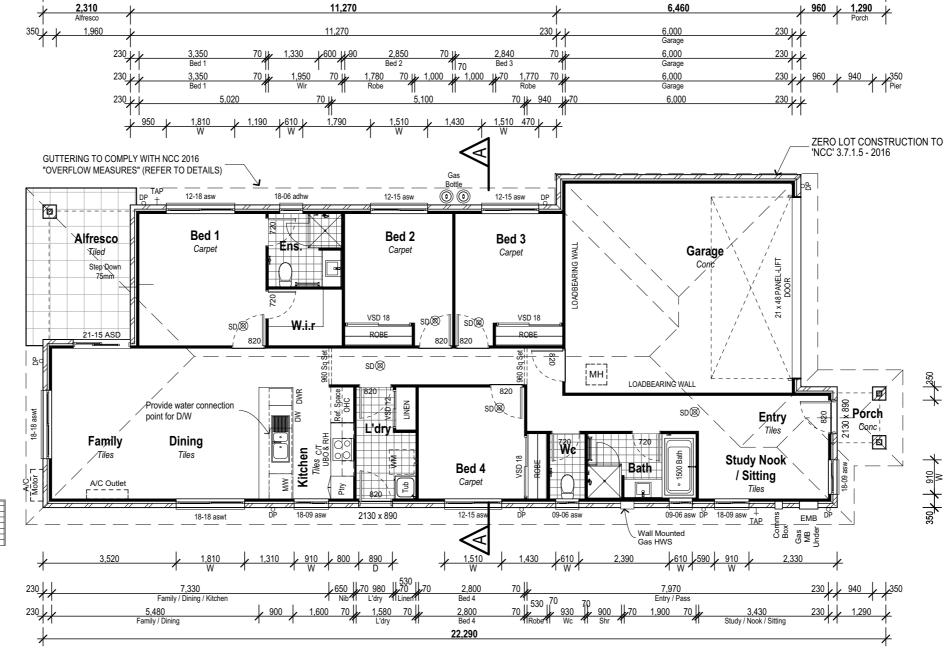

22,290

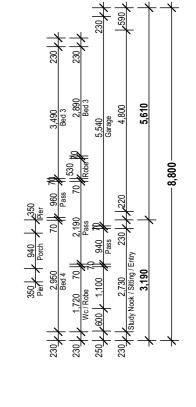

Floor A	Areas
Living	124.2
Garage	36.1
Alfresco	11.2
Porch	4.9
	176.4 m



Address: P.O. BOX 600
PARADISE POINT, 4216
www.adevelopments.com.au

ACN: 116332220 ABN: 77116332220 QBSA: 1086689

"Building a Shared Vision"


All Content Copyrighted: The design and/or print is the property of G Developments P/L and is protected by the Commonwealth Copyright Act 1968. It must not be used or reproduced in whole or in part without written permission. Any attempt to copy, use or reproduce the same, in whole or in part will result in leaged proceedings. USERBAL NOTES: Drawing are to be read in conjunction with the relevant client-builder controct. Controct is to take precedence over drawings including but not limited to: - finishes, includins, supprades, exclusions, additional costs and works by the owner/builder. Incorrect Inclusions or omissions or hypographical errors are not to be used in the interpretation of any information in these dowings. Nor can they be used to claim any additional or ollemetal learns a services as a result of such eners. In additional or ollemetal learns a services as a result of such eners. In additional or ollemetal learns a services as a result of such eners. In a different control of the properties					
Drawings are to be read in conjunction with the relevant clein-builder control. Contract is to take precedence over drawings including but not limited to: - finishes, inclusions, upgrades, exclusions, additional costs and works by the owner/builder, incorrect inclusions or orinsions or typographical error are not to be used in the interpretation of any information in these drawings. Nor can they be used to claim any additional or alternate literaction or services as a result of such error. The incorrect or certified details shall be subject to subsequent correction by the building company and documentation re-sissed. A XX.XX.2018 Pre-Construction Copy	This design and/or print is the property of G Developments P/L and is protected by the Commonwealth Copyright Act 1968. If must not be used or reproduced in whole or in part without written permission. Any attempt to copy, use or reproduce the			"2018 Design Range"	
additional or alternate items or services as a result of such errors. The incorrect or amilted details shall be subject to subsequent correction by the building company and documentation re-issued. A XX.XX.2018 Pre-Construction Copy	Drawings are to be read in conjunction with the relevant client-builder contract. Contract is to take precedence over drawings including but not limited to: - finishes, inclusions, upgrades, exclusions, additional costs and works by the owner/builder, Incorrect inclusions or omissions or typographical errors are not to be used in the interpretation of any				
by the building company and documenfation re-issued. A AAAA.2016 Pre-Construction Copy					
		Α	XX.XX.2018	Pre-Construction Copy	?
	DIMENSIONS TO BE READ IN PREFERENCE TO SCALING	Rev	Date	Amendments	В

Client:	Site Address:
Mr & Mrs #Client Family Name	Lot ???
	- Road
Product:	Estate Name
Coogee 176	SUBURB QLD 4???
Traditional Facade	DP: Unregistered
Garage to RHS	LGA: Council

Floor Plan			
Plot Date: 29/6/2018	Drawn: Rev:		Rev:
Scale: 1:100	Checked:	Checked: Checked Date:	
Sheet: 03 Job No: 405###			



Communications Pre-wired

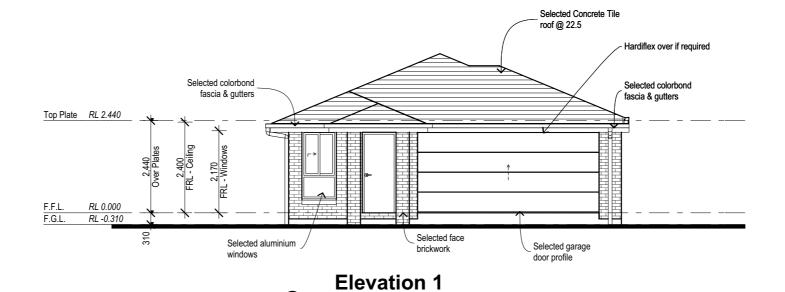


Provide full ht. Masonry articulation as per engineers report

Provide security screens to all openable

windows & sliding glass doors

Note:

450mm Eave U.N.O.

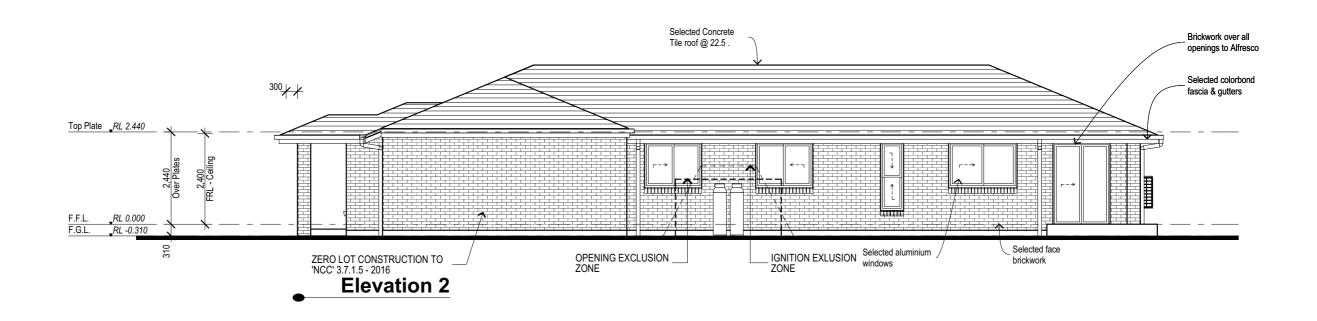



Address: P.O. BOX 600 PARADISE POINT, 4216 ww.adevelopments.com.a

ACN: 116332220 ABN: 77116332220 QBSA: 1086689

All Content Copyrighted:-	Г	
All Content Copyrighted: All Content Copyrighted: This design and/or print is the property of G Developments P/L and is protected by the Commonwealth Copyright Act 1968, if must not be used or reproduced in whole or in part without written permission. Any attempt to copy, use or reproduce the same, in whole or in part, wall result in legal proceedings.		
GENERAL NOTES: trawings are to be read in conjunction with the relevant client-builder contract. Contract is to take precedence over drawings including but		
oot limited to: - finishes, inclusions, upgrades, exclusions, additional costs and works by the owner/builder. Incorrect inclusions or omissions or typographical errors are not to be used in the interpretation of any		
formation in these drawings. Nor can they be used to claim any difference of the dif		
ncorrect or omitted details shall be subject to subsequent correction by the building company and documentation re-issued.	Е	
DIMENSIONS TO BE READ IN PREFERENCE TO SCALING	Ĺ	

NG	Rev	Date	Amendments	By	ı
ŀ				_	ı
tion	Α	VV VV 2018	Pre-Construction Copy	??	ı
any The					ĺ
any					ĺ
onal ions					ĺ
					ĺ
ider but					ı
					H
the					ĺ
nout					ı
8. It			"2018 Design Range"		ı
P/L					4

Client:	Site Address:		
Mr & Mrs #Client Family Name	Lot ???		
	- Road		
Product:	Estate Name		
Coogee 176	SUBURB QLD 4???		
Traditional Facade	DP: Unregistered		
Garage to RHS	LGA: Council		

Elevations			
Plot Date: 29/6/2018	Drawn: ??		Rev:
Scale: 1:100	Checked:	Checked Date:	A
Sheet: 04	Job No:	5###	




Communications Pre-wired

Note: 450mm Eave U.N.O.

Note:


Provide security screens to all openable windows & sliding glass doors

Provide full ht. Masonry articulation as per engineers report

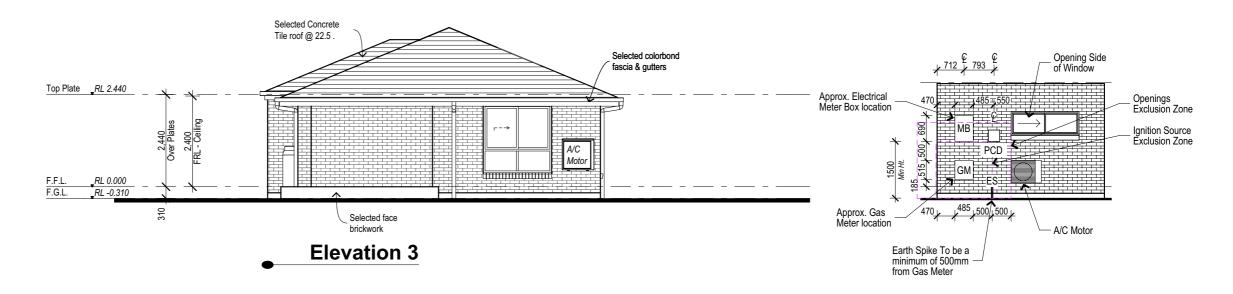

Services Detail

1:100

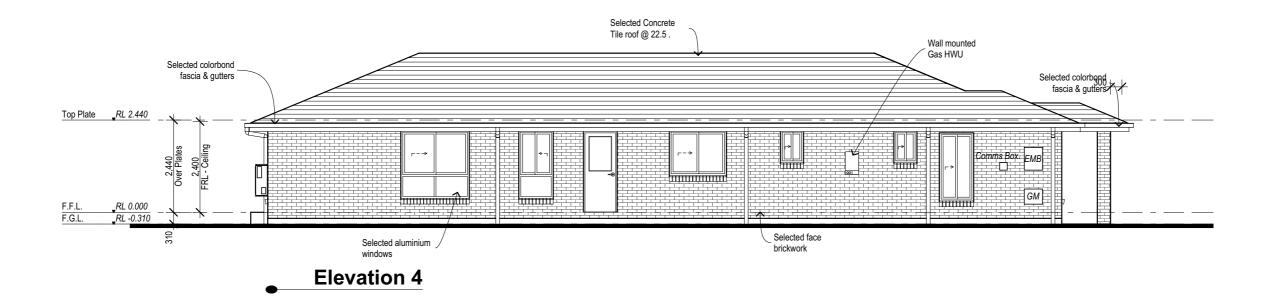




Mr & Mrs #Client Family Name	Site Address: Lot ??? - Road	
Product: Coogee 176	Estate Name SUBURB QLD 4??	
Traditional Facade Garage to RHS	DP: Unregistered LGA: Council	

Elevations			
Plot Date: 29/6/2018	Drawn: ??		Rev:
Scale: I:100	Checked:	Checked Date:	Α
Sheet: 05	Job No: 405###		


Communications Pre-wired

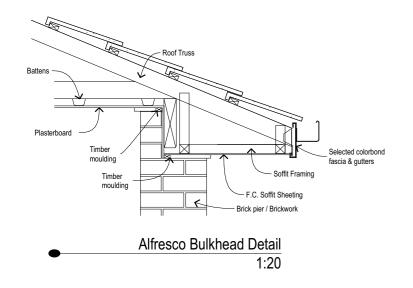


GUTTER AND DOWNPIPES TO COMPLY WITH NCC 2016 PART 3.5.2

OVERFLOW MEASURES TO GUTTERS TAKEN FROM NCC 2016 PART 3.5.2.4.					
RAINFALL DURATION INTENSITIES (TABLE 3.5.2.1)	OVERFLOW VOLUME FOR CONTINUOUS MEASURE (L/s/m) (TABLE 3.5.2.3a)				
5 MINUTE DURATION RAINFALL INTENSITIES (100 YEARS)			OVERFLOW VOLUME FOR CONTINUOUS MEASURE (L/s/m)		
LOCALITY (mm/h)	DESIGN (mm/h)	40.0	1.4 L/s/m required		
IPWICH 278 BRISBANE 305 VICTORIA PT 320	300 325 325	16.0	1.5 L/s/m provided (REFER TO TABLE 3.5.2.4)		

Tab	Table 3.5.2.4 ACCEPTABLE OVERFLOW MEASURES			
Tab	ole a. Acceptable co	ntinuous o	verflow measure	
Des	scription	Overflow	Construction	
Cor	ntrolled back gap h-	Capacity (L/s/m)		
(a)	a permanent minimum 10 mm spacer installed between the gutter back and the fascia; and	1.5	Top of fascia 10 mm	
(b)	one spacer per bracket, with the spacer not more than 50 mm wide; and		Spacer	
(c)	the back of the gutter installed a minimum of 10 mm below the top of the fascia.			

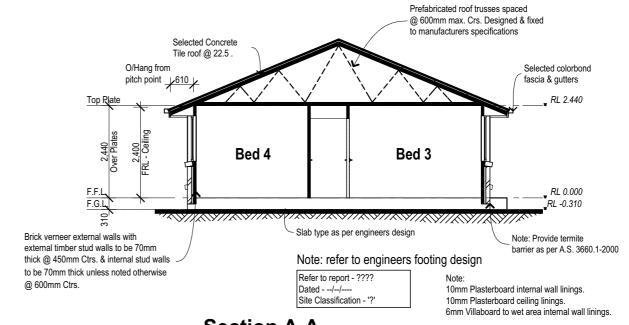

Section A-A

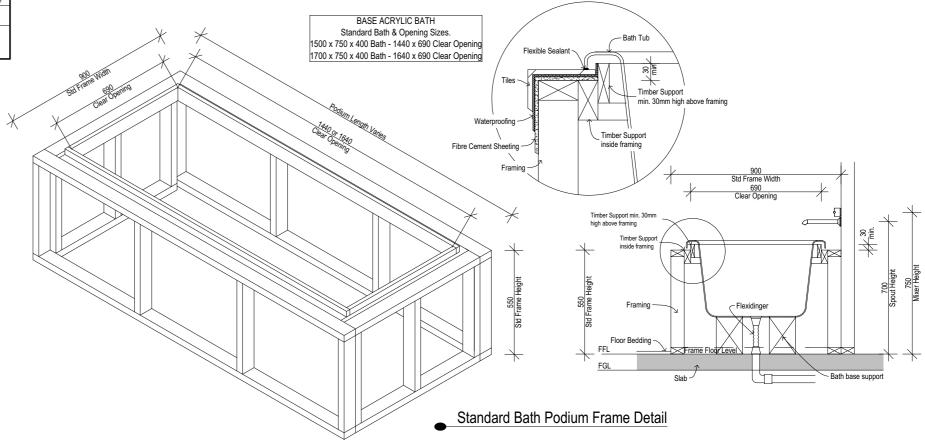



Address: P.O. BOX 600 PARADISE POINT, 4216

> ACN: 116332220 ABN: 77116332220 QBSA: 1086689

NSIONS TO BE READ IN PREFERENCE TO SCALING

"2018 Design Range" A XX.XX.2018 Pre-Construction Copy Garage to RHS

Mr & Mrs #Client Family Name Coogee 176 **Traditional Facade**

Lot ??? Road Estate Name SUBURB QLD 4??? DP: Unregistered LGA: Council

Site Address:

Section & Details Plot Date: 29/6/2018 Α Checked Date: 1:100, 1:20

405### 06

TOILET ROLL HOLDERS TO BE 700mm HIGH AND 700mm OUT AND FITTED TO THE SAME SIDE WALL AS THE HINGED DOOR IF APPLIACBLE.

BATH MIXER TO BE AT 750mm HIGH BATH SPOUT TO BE AT 700mm HIGH

TILING SHOWN FOR ILLUSTRATION PURPOSES ONLY. ACTUAL TILING MAY DIFFER FROM DRAWINGS.

NOTE: ALL DIMENSIONS ARE APPROX. ONLY AND MAY VARY DEPENDING ON PRODUCT SELECTION AND ARE SHOWN FROM FLOOR LEVEL AND DO NOT INCLUDE BEDDING OR FLOOR TILES.


TOWEL RAILS, TOILET ROLL HOLDERS, SHOWER SCREENS, VANITIES, POWER POINTS AND TILES ARE INDICATIVE ONLY AND WILL VARY DEPENDING ON PRODUCT SELECTION.


LIFT OFF HINGES TO COMPLY WITH BCA 3.8.3.3


CLEAR LAMINATED GLASS SHOWER SCREENS WITH POWDERCOATED ALUMINIUM FRAMES TO SHOWERS


ALL MIRRORS AT 900mm HIGH


TAPWARE SHOWN FOR ILLUSTRATION PURPOSES ONLY.

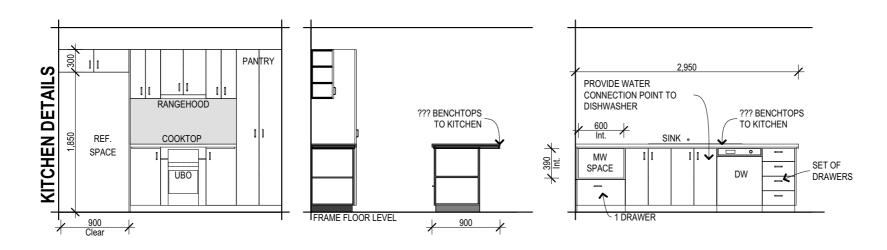

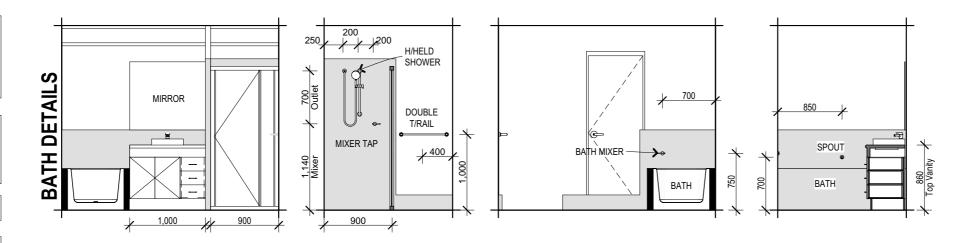

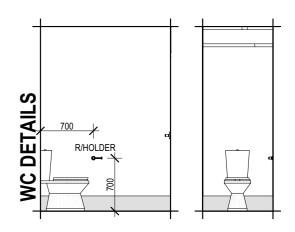

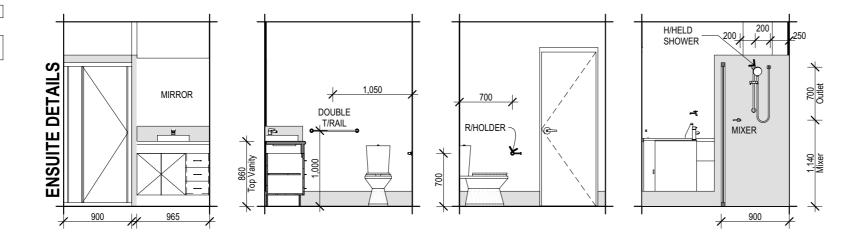

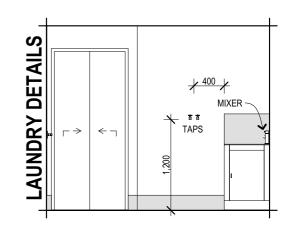



Address: P.O. BOX 600 PARADISE POINT, 4216 ww.adevelopments.com.a

> ACN: 116332220 ABN: 77116332220 QBSA: 1086689

written permission. Any attempt to copy, use or reproduce the same, in whole or in part, will result in legal proceedings.
GENERAL NOTES: Drawings are to be read in conjunction with the relevant client-builder contract. Contract is to take precedence over drawings including but not limited to: - finishes, inclusions, upgrades, exclusions, additional costs and works by the owner/builder, incarred inclusions or or sissor or spoographical errors are not to be used in the interpretation of any information in these drawings. Not can they be used to claim any additional or alternate literas or services as a result of such errors. The incorrect or ornitred details shall be subject to subsequent correction.
by the building company and documentation re-issued. DIMENSIONS TO BE READ IN PREFERENCE TO SCALING

pyrighted: / /or pint is the property of G Developments P/L d by the Commonwealth Copyright Act 1948. It ed or reproduced in whole or in part without no. Any attempt to copy, use or reproduce the or in part, will result in legal proceedings.			"2018 Design Range"		
ad in conjunction with the relevant client-builder to take precedence over drawings including but hes, inclusions, upgrades, exclusions, additional e owner/builder, Incorrect inclusions or omissions are not to be used in the interpretation of any					
drawings. Nor can they be used to claim any e items or services as a result of such errors. The				. I	
details shall be subject to subsequent correction any and documentation re-issued.	Α	XX.XX.2018	Pre-Construction Copy	??	
BE READ IN PREFERENCE TO SCALING	Rev	Date	Amendments	Ву	L

Client:	Site Address:
Mr & Mrs #Client Family Name	Lot ???
	- Road
Product:	Estate Name
Coogee 176	SUBURB QLD 4???
Traditional Facade	DP: Unregistered
Garage to RHS	

Internal Elevations			
Plot Date: 29/6/2018	Drawn:		Rev:
Scale: 1:50	Checked:	Checked Date:	Α
Job No: 405###			

Communications Pre-wired

	ELECTRICAL LEGEND				
Туре	Description	Qty			
®	Ceiling Fan & Light	5			
©#	Circular Fluro	1			
\triangleright	Data Point	1			
0	Downlight - Ceiling Light Outlet	11			
	DPP (GPO)	14			
❤	Exhaust Fan	2			
>	Phone Point	2			
	Single Fluro	1			
SD⊗	Smoke Detector	6			
4	SPP (GPO)	6			
	SPP (Waterproof)	1			
+ •	TV Point	2			
-	Wall Light	2			

Position of Electrical Points Subject to Construction Constraints

- Light Switches @ 1350mm Above FL

- Wall Mounted Lights @ 2000 Above FL - Power Outlets @ 300mm Above FL

(Except for the following)


1000 - Kitchen Bench 600 - Microwave U/Bench (MW)

1800 - Rangehood (RH) 1800 - Refrigerator (Ref)

600 - Dishwasher (DW) 1500 - Washing Machine (WM) 1000 - Laundry Bench 1000 - Vanities

Smoke Detectors

Approx. Position - installed as per BCA 3.7.2 & comply with

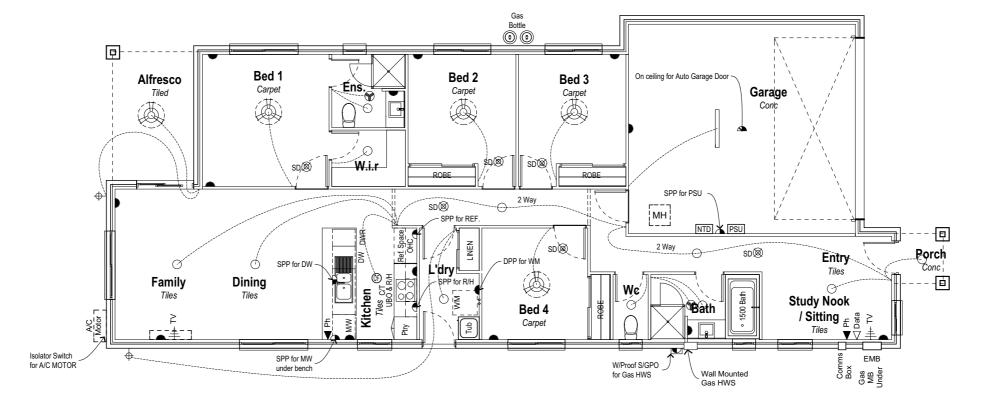

Comms Box Connection Includes:

- * Lead in Cabling
- * Wiring Cabinet
- Gpo Near Wiring Cabinet
- * Lead in Conduit

All Above Items to Fibre Network Suppliers Specification

Fibre Network Supplier to Provide:

*Network Terminal Device

* PSU (Batery Back-Up by Home Owner)



Address: P.O. BOX 600 PARADISE POINT, 4216

> ACN: 116332220 ABN: 77116332220 QBSA: 1086689

"Building a Shared Vision"

ENSIONS TO BE READ IN PREFERENCE TO SCALIN

		"2018 Design Range'	
A	XX.XX.2018	Pre-Construction Copy	??
Rev	Date	Amendments	Ву

Site Address: Mr & Mrs #Client Family Name Lot ??? - Road Estate Name Coogee 176 SUBURB QLD 4??? **Traditional Facade** DP: Unregistered Garage to RHS LGA: Council

Electrical Plan			
Plot Date: 29/6/2018	Drawn: ??		Rev:
Scale: I:100	Checked:	Checked Date:	A
O8 Job No: 405###			


Communications Pre-wired


Note:

Refer to engineers design for footing & slab details

Provide termite barrier as per a.s. 3660.1-2000

Provide full ht. Masonry articulation at 5.0m max. Crs as per engineers report

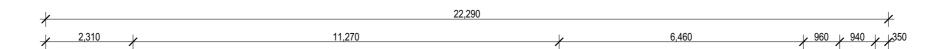

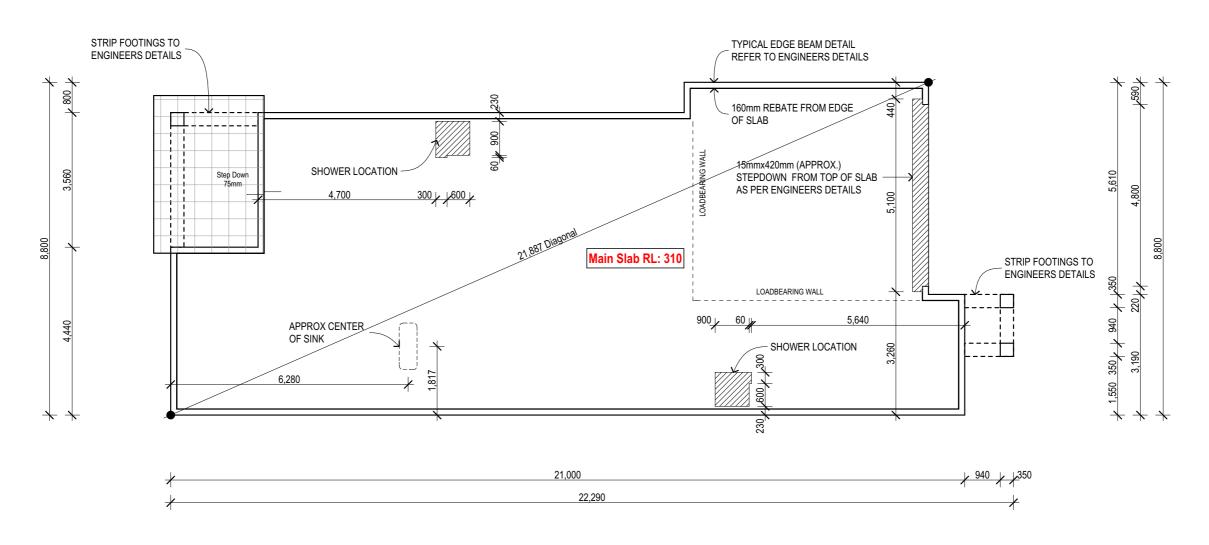



Address: P.O. BOX 600 PARADISE POINT, 4216 ww.adevelopments.com.au

> ACN: 116332220 ABN: 77116332220 QBSA: 1086689

	DIMENSIONS TO BE READ IN PREFERENCE TO SCALING	Rev	Date	Α
	additional or alternate items or services as a result of such errors. The incorrect or omitted details shall be subject to subsequent correction by the building company and documentation re-issued.		XX.XX.2018	Р
,	GENERAL NOTES: Drawings are to be read in conjunction with the relevant client-builder contract. Contract is to take precedence over drawings including but not limited to: - finishes, inclusions, upgrades, exclusions, additional costs and works by the owner/builder. Incorrect inclusions or omissions or typographical errors are not to be used in the interpretation of any information in these drawings. Not can they be used to claim any			
	All Content Copyrighted: Ond is protected by the Commonwealth Copyright Act 1988. If must not be used or reproduced in whole or in part without written permission. Any attempt 10 copy, use or reproduce the same, in whole or in part will result in legal proceedings.			

		"2018 Design Range"		M
				Pro
	YY YY 2018	Pre-Construction Copy	??	Tr
_	Date	Amendments	By	G

ient:	Site Address:
Ir & Mrs #Client Family Name	Lot ???
	- Road
oduct:	Estate Name
Coogee 176	SUBURB QLD 4???
raditional Facade	DP: Unregistered
Sarage to RHS	LGA: Council

Slab Plan			
Plot Date: 29/6/2018	Drawn: ??		Rev:
Scale: 1:100	Checked:	Checked Date:	Α
O9 Job No: 405###			

Communications Pre-wired

BRACING SCHEDULE

- UPPER OR SINGLE STOREY
- Concrete Tile ROOF
- JOINT GROUP = JD4

N3

DIF	RECTION A 🗢	REQUIRED kN = 24.4			
CODE	TYPE	LENGTH	VALUE	No.	TOTAL kN
Α	STRUCTURAL PLY BRACE @ 6.0 kN/m	450mm	2.7kN	0	00.0
Α	STRUCTURAL PLY BRACE @ 6.0 kN/m	500mm	3.0kN	0	00.0
Α	STRUCTURAL PLY BRACE @ 6.0 kN/m	600mm	3.6kN	1	3.6
Α	STRUCTURAL PLY BRACE @ 6.0 kN/m	900mm	5.4kN	5	27.0
Α	STRUCTURAL PLY BRACE @ 6.0 kN/m	1800mm	10.8kN	0	00.0
AS	STEEL ANGLE BRACE @ 1.5 kN/m	1800mm	2.7kN	0	00.0
AS	STEEL ANGLE BRACE @ 1.5 kN/m	2400mm	3.6kN	0	00.0
AS	STEEL ANGLE BRACE @ 1.5 kN/m	2700mm	4.0kN	0	00.0
С	BRACING BRICK PIER @ 1.5 kN (both direct	ions)	1.5kN		


RESISTANCE PROVIDED kN = 30.6

DIF	RECTION B 合	R	REQUIRED kN = 65.9			
CODE	TYPE	VALUE	No.	TOTAL kN		
В	STRUCTURAL PLY BRACE @ 6.0 kN/m	450mm	2.7kN	0	00.0	
В	STRUCTURAL PLY BRACE @ 6.0 kN/m	500mm	3.0kN	0	00.0	
В	STRUCTURAL PLY BRACE @ 6.0 kN/m	600mm	3.6kN	1	3.6	
В	STRUCTURAL PLY BRACE @ 6.0 kN/m	900mm	5.4kN	13	70.2	
В	STRUCTURAL PLY BRACE @ 6.0 kN/m	1800mm	10.8kN	0	00.0	
В	STRUCTURAL PLY BRACE @ 6.0 kN/m	2400mm	14.4kN	0	00.0	
В	STRUCTURAL PLY BRACE @ 6.0 kN/m	2700mm	16.2kN	0	00.0	
BS	STEEL ANGLE BRACE @ 1.5 kN/m	1800mm	2.7kN	0	00.0	
BS	STEEL ANGLE BRACE @ 1.5 kN/m	2400mm	3.6kN	0	00.0	
BS	STEEL ANGLE BRACE @ 1.5 kN/m	2700mm	4.0kN	0	00.0	
С	BRACING BRICK PIER @ 1.5 kN (both directions)		1.5kN	0	00.0	
	RESISTANCE PROVIDED kN = 73.8					

Notes:
Plywood bracing walls less than 900mm long require M12 rods, top plate to bottom plate.
Bracing walls sheeted both sides require M16 tie down rods at each end and intermediately
@ 1200mm ctrs.

Internal ply bracing walls should be with M12 ramset cynabolts at each end and @ max of 1200mm ctrs with 65mm penetration into the slab.

External bracing wall should be fixed M12 chemsets.

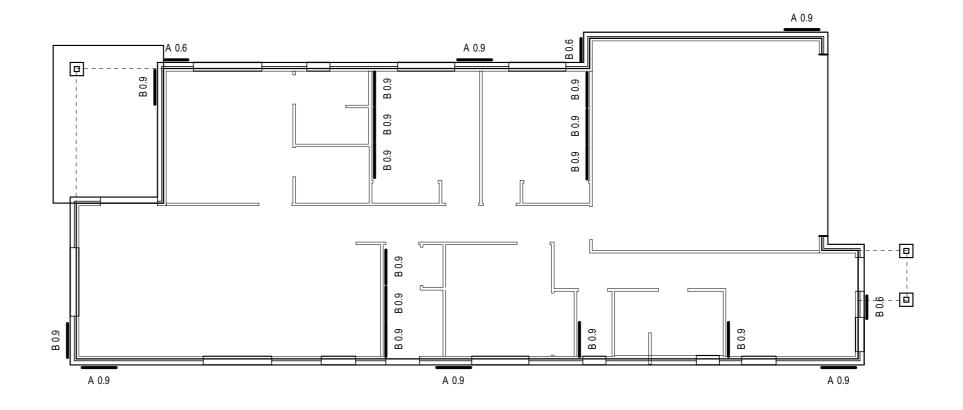



Address: P.O. BOX 600 PARADISE POINT, 4216

ACN: 116332220 ABN: 77116332220

QBSA: 1086689 "Building a Shared Vision"

ENSIONS TO BE READ IN PREFERENCE TO SCALING

		"2018 Design Range"	
Α	XX.XX.2018	Pre-Construction Copy	??
Rev	Date	Amendments	Ву

Client:
Mr & Mrs #Client Family Name Site Address: Lot ??? - Road Product: Estate Name Coogee 176 SUBURB QLD 4??? **Traditional Facade** DP: Unregistered Garage to RHS LGA: Council

Bracing Plan					
Plot Date: 29/6/2018	Drawn: ??		Rev:		
Scale: 1:100, 1:1	Checked:	Checked Date:	Α		
Sheet:	Job No:) 5###			

SPECIFICATIONS:-

N.3 CONC. TILE ROOF SINGLE STORY

BY LAWS & CODES.

All construction shall be designed and built to comply with the Building Act 1975 and the Building Code of Australia 2010 edition & subsequent amendments to date & A.S 1684.2 2006 (residential timber framed construction)

MANUFACTURES SPECIFICATIONS.

Means a current specification approved by the Local Authority for use under the conditions applicable in this industry.

MATERIALS & COMPONENTS.

- 1. All Materials shall be new.
- 2. Timber sizes and details not shown shall comply with A.S 1684.2. All timber, truss sizes and details shall be as per A.S 1684.2 (2006)
- 3. Concrete ftg. 20MPa., remainder 20 MPa.
- 4. STEEL: Shop primed (all fixing bolts shall be hot dipped galvanised).
- 5. ROOFING: Selected sheet roofing fixed in accordance with manufacturers specifications.
- 6. WALLS: Brick Veneer (wall ties @ 450 hor x 600 vert) to comply with AS 3700 & Supp.1 SAA Masonry Code. Prefabricated wall frames - timber sizes shall comply with A.S 1684.2 (2006)
- 7. WALL LINING: Plasterboard generally to all walls and ceilings (10mm thick to walls 10mm thick to ceiling) fixed in accordance with manufacturers specifications. 6.0mm Villaboard to bathroom areas.
- otherwise) fixed in strict accordance with manufacturers specifications all sizes shown on plan.
- 9. DOORS: Entry doors and timber frame shall be as per specifications. Where WC doors do not open outwards from WC room enclosure, they shall be provided with externally removable hinges.

8. ALUMINIUM WINDOWS & DOORS: All windows and sliding glazed doors shall be powder coat finished (unless stated

- 10. VENTILATION: Internal WC enclosures shall be vented in accordance with Part F4.5 or F4.6 of the Building Code of Aust.
- 11. D.P.C.: Provide approved damp proof course between bottom plates and concrete/masonry to all external walls and to all internal wet areas
- 12. FLASHINGS: All windows and sliding doors flush with gable ends shall have 50mm galvabond window flashing above.
- 13 EXTERNAL CLADDING: Refer to Elevations for details

TIE DOWN FIXINGS OF ROOFING, BATTENS & TRUSSES TO BE AS PER THE MANUFACTURERS SPECIFICATIONS FOR N3 WIND RATING

NOTE: IN ADDITION TO THE REQUIREMENTS FOR TIE-DOWN AND BRACING WALLS, THE BOTTOM PLATES OF ALL WALLS SHALL BE FIXED TO THE CONCRETE SLAB @ 1200mm MAX CRS. FASTENERS TO BE EITHER HAMMERED, FIRED, SCREWED OR EXPANSION MASONARY

ROOF SF	PAN				5	STUDS AT SIDE
LINTELS	1400	1900	3600	4500	6600	NO.(MGP10
900 1200 1500 1800 2100 2400 2700 3000 3300 3600 3900 4200 480	120x35 MGP12 120x35 MGP12 120x35 MGP12 190x35 MGP10 190x35 MGP10 190x70 MGP10 240x36 LVL 240x45 LVL 240x63 LVL 300x45 LVL 300x63 LVL	120x35 MGP12 120x35 MGP12 190x35 MGP10 190x35 MGP10 190x70 MGP10 240x36 LVL 240x63 LVL 240x63 LVL 300x62 LVL	120x35 MGP12 190x35 MGP10 190x35 MGP10 190x35 MGP10 240x36 LVL 240x63 LVL 230x65 TR NE & TR	120x35 MGP12 190x35 MGP10 190x35 MGP12 240x36 LV 240x36	120x35 MGP 190x2 FP 190x2 FP 190x2 FP 260x65 17C 270x65 18C 300x65 18C 360x65 18C 360x65 18C	2 2 2 2 3 3 3 3 3 3 3 4 4 4 4
17C = G	MACHINATED VENE LUE LAMINATED LUE LAMINATED	PINE BEAM	SD2 JI	D4 (TRADA) D4 TILLING D1 HYNEBE D1 HYNEBE	TÍMBER EAM	

TIEDOWN SCHE	DULE N3 T	ILE ROOF (UPLIFT LOAD WIDTH)	7500)		
MEMBERS	UPLIFT	METHOD	KN PROVIDED	DETAIL	METHOD
ROOF BATTEN TO RAFTER	0.5kn	As per Manufacturers requirements			
TRUSSES TO TOP PLATE @ 600 CRS	4.1kn	As per Manufacturers requirements	·		
PLATES TO STUDS	12.0kn	1/M12 threaded rod at every window, door jamb, every corner, every end and intermediate at max 1800 crs	20.0kn		
LINTELS < 2.4	8.4kn	1/30x0.8 G.I. strap with 6/2.8 dia nails each end top and bottom each side of opening	8.4kn		
LINTELS < 4.8	16.7kn	2/30x0.8 G.I. strap with 6/2.8 dia nails each end top and bottom each side of opening	17.0kn		
LINTELS < 5.7	20.0kn	1/M12 threaded rod each side side of opening.	20.0kn	100mm MAX	
BOTTOM PLATE TO CONCRETE (single storey)	8.2kn	1/M12 anchor at every window, door jamb, every corner, every end and intermediate at max 1800 crs	20.0kn		
BOTTOM PLATE (upper floor) TO TOP PLATE (lower floor)	8.2kn	1/M12 anchor at every window, door jamb, every corner, every end and intermediate at max 1800 crs	20.0kn		
VERANDAH PLATE TO POST 3.0m SPAN	9.9kn	2/M12 hex head bolts	21.0kn		
PLATES TO STUDS (lower floor)	8.2kn	1/M12 threaded rod at every window, door jamb, every corner, every end and intermediate at max 1800 crs	20.0kn		
BOTTOM PLATE TO CONCRETE (lower floor)	8.2kn	1/M12 anchor at every window, door jamb, every corner, every end and intermediate at max 1800 crs	20.0kn		

NOTE:- PREFABRICATED FRAME SUPPLIER IS TO SUPPLY SCHEDULE & CERTIFICATION FOR FRAMES SUPPLIED. DESIGNED IN ACCORDANCE WITH THE BUILDING CODE OF AUSTRALIA AND THE BUILDING ACT 1975.



Address: P.O. BOX 600 PARADISE POINT, 4216

> ACN: 116332220 ABN: 77116332220 QBSA: 1086689

"Building a Shared Vision"


ENSIONS TO BE READ IN PREFERENCE TO SCALIN


"2018 Design Range"				
		2010 Beolgh Range		
			I	
Α	XX.XX.2018	Pre-Construction Copy	??	
Rev	Date	Amendments	Ву	


Site Address: Mr & Mrs #Client Family Name Lot ??? - Road Estate Name Coogee 176 SUBURB QLD 4??? **Traditional Facade** DP: Unregistered Garage to RHS LGA: Council

Tiedown Details				
Plot Date: 29/6/2018	Drawn:		Rev:	
Scale:	Checked:	Checked Date:	Α	
Sheet:	Job No:	05###		

ROOF BRACING

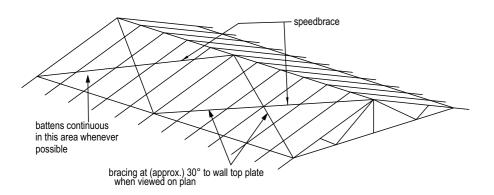

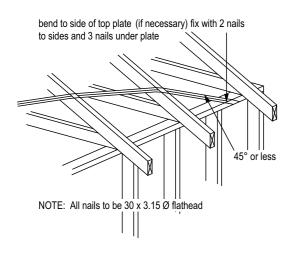

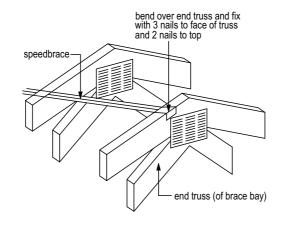

WALL BRACING

Bracing to be located as shown on plan.
Structural ply to external walls (inside cavity) - refer to detail Bracing Type A.

All bracing shall be fixed in strict accordance to manufacturers specifications.

The top of all timber bracing walls shall be fixed to roof and ceiling - refer to details "C" and "D".

STRUCTURAL PLYWOOD - 6.0kN/m

F14, 4mm thick min. structural plywood on outer face of stud wall nailed to frame with 30 x 2.8mm dia flathead nails or equivalent. Studs @ 450 ctrs behind panels.

PLYWOOD BRACING PANELS- equal to or greater than 900mm lengths

Nailing ctrs: Top & Bottom plates - 50mm

Vertical edges - 150mm Intermediate studs - 300mm

Fixings: Top - Method A, B, C, or D per

900mm length

Bottom - 1/M12 Bolt each end &

@ 1200 ctrs max

PLYWOOD BRACING PANELS- less than 900mm ply lengths

Nailing ctrs: Top & bottom plates - 150mm

Vertical edges - 150mm Intermediate studs - 300mm Top - Method A, B, C or D per

900mm ply length Bottom - 1/M12 full height rod


each end.

Fixings:


kN values: 0.6m = x 3.6kN (reduced by 0.6)

0.7m = x 4.2kN (reduced by 0.7) 0.8m = x 4.8kN (reduced by 0.8)


BRACING TYPE 'A' structural plywood detail - 6.0kN/m

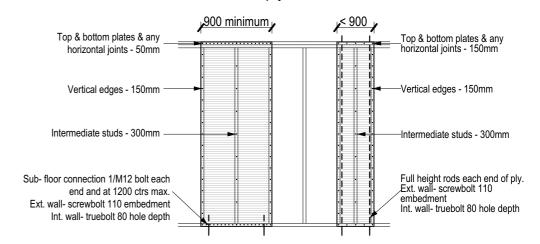



BRACING TYPE 'B' metal angle brace detail - 1.5kN/m

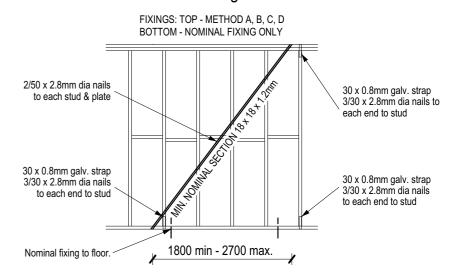


WALL BRACING UNDER SOFFIT DETAILS

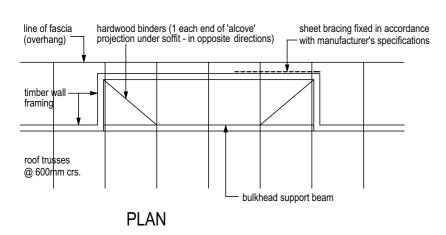

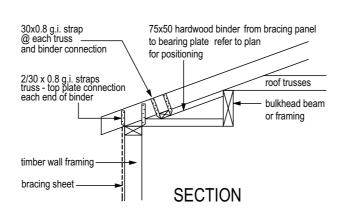

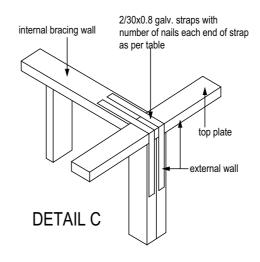

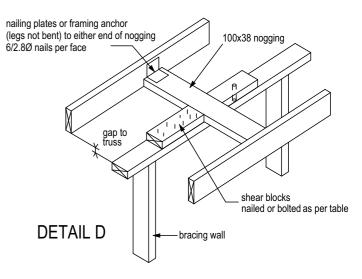



	All Content Copyrighted: Ond is protected by the Commonwealth Copyright Act 1988. If must not be used or reproduced in whole or in part without written permission. Any attempt to copy, use or reproduce the same, in whole or in part willing the commonwealth Copyright Act 1988. If we can be used or reproduced in whole or in part willing the profession. Any attempt to copy, use or reproduce the same, in whole or in part, will result in legal proceedings.			"2018 Design Range"	
,	GENERAL NOTES: Drawinas are to be read in conjunction with the relevant client-builder				
	contract. Contract is to take precedence over drawings including but not limited to: - finishes, inclusions, upgrades, exclusions, additional				
	costs and works by the owner/builder. Incorrect inclusions or omissions or typographical errors are not to be used in the interpretation of any				
	information in these drawings. Nor can they be used to claim any additional or alternate items or services as a result of such errors. The				
	incorrect or omitted details shall be subject to subsequent correction by the building company and documentation re-issued.	Α	XX.XX.2018	Pre-Construction Copy	??
	DIMENSIONS TO BE READ IN PREFERENCE TO SCALING	Rev	Date	Amendments	Ву

Client:
Mr & Mrs #Client Family Name

Product:
Coogee 176
Traditional Facade
Garage to RHS

Site Address:
Lot ???
- Road
Estate Name
SUBURB QLD 4???
DP: Unregistered
LGA: Council