

SHEET	DESCRIPTION
01	Cover sheet
02	Site Plan
03	Floor Plan
04	Elevations
05	Elevations
06	Internal Elevations
07	Slab Plan
08	Electrical Plan
09	Section AA
10	Bracing Plan
11	Hedown Details

NOTES: IMAGES ARE DIAGRAMATIC ONLY REFER TO ELEVATIONS FOR DETAILS

7	SEPE OPHER ST

ADDRESS: P.O. BOX 600 PARADISE POINT, 4216

ACN: 116332220 ABN: 77116332220 QBSA: 1086689

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DIMENSIONS TO BE READ IN PREFERENCE TO SCALING

	CLIENT'S SIGNITURE: DATE:	.] [
i right	NOTES:	٦,
		Ι.

PRODUCT: Newtown 190 **Traditional Facade** Garage to RH

"2018 Design Range"

Α **REV** 11.12.17 PRE-CONSTRUCTION COPY

DATE AMENDMENTS

?? Client Full Name SITE ADDRESS: Lot ??? ?? Street ?? Suburb, QLD ??postcode

??

BY

Cover sheet DD.MM.YY SCALE: CHECKED: SHEET: ຶ405??? 01

SITEWORKS / NOTES

CUT BATTER:- 1:3 FILL BATTER:- 1:3

NO HEAVY COMPACTION **OVER SERVICES**

G DEVELOPMENTS TURN KEY PACKAGE

DRIVEWAY, PATH TO FRONT DOOR, ALFRESCO AND

BEST PRACTICE PROCEDURES FOR EROSION & SEDIMEN ONTROL AS OUTLINED BY G.C.C.C. REGULATIONS TO BE

ENGINEERS WIND CLASSIFICATION:

TENDER SUBJECT TO LOCAL SHIRE COUNCIL ENERGY **EFFICIENCY REQUIREMENTS**

LOCATION OF YARD GUILLIES ARE

INDICATIVEONLY & MAY BE MOVED
AT THE DISCRETION OF THE BUILDER

ON SITE TO SUIT THE SITE CONDTIONS

TENDER SUBJECT TO FULL FOR DAMAGE TO COVENANT APPROVAL BY **EXISTING ACCESS** CLIENT PRIOR TO COUNCIL WAY, RETAINING LODGEMENT WALLS OR FENCES

☑ - YARD GULLY

SITEWORKS G DEVELOPMENTS TAKES NO

CUT:-RESPONSIBILITY FILL:-

250mm SLAB R.L:- 0.123m AHD PAD R.L:- 0.000m AHD

250mm

BUILDING PLATFORM HEIGHT SHOWN IS APPROX. ONLY & MAY VARY ON SITE DUE TO SITE CONDITIONS.

ATURAL GAS AVAILABLE ON SITE. PROVIDE METER BOX FOR DNNECTION FROM GAS MAIN TO HOUSE BY G DEVELOPMENTS



CLAY LOAM

NO GRASS

hereon are related to AHD. Prior to any construction the relevant authority should be contacted for possible minimum floor level requirements and flood information.

Levels & Contours shown

SITE AREA: ???m²

SITE COVER: ???%

Services shown hereon have been located where possible by field survey.

If not able to be located. services have been plotted from the records of relevant authorities where available.

Prior to any excavation or construction on the site, the relevant authority should be contacted for possible location of further underground services.

SITE: RIVERSTONE CROSSING UPPER COOMER/ LOT 608 ON DISCLOS _____.

GOLD COAST C. LOCAL AUTH: COUNTY: PARISH:

CEDAR AREA: 462m² UBD REF: GC16 B9

CONTOUR AND DF

THIS SURVEY MAPS THE SITE FF 3 AND LEVEL, IT DOES NOT GUARANT! A POSITION R FENCES. OF PEGS, ALLOTMENT BOUND/ CHECK TITLE FOR ANY EASEN

SERVICES O/H POWER **U/G POWER** YES (NOT CONN)

WATER YES (NO METER) **TELECOM** YES (NOT CONN) GAS NOT FOUND SEWER

ROOFWATER FRONT/PIT STORMWATER FRONT/PIT

✡

LEGEND O/H LIGHT S/WATER P FIRE HYD' WATER V

MOUNT NON-N. (ERB REF RL. 21.47


DATUM AHD (VIA PSM #172715)

1800 HIGH TIMBER FENCE -FENCE (m) LENGTH OF TIMBER FENCE TOTAL LENGTH OF FENCE = ???m

COMMS. PREWIRED

FENCE LEGEND

PROPOSED RESIDENCE

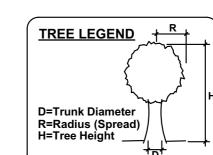

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NOTES:

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Newtown 190 CLIENT'S SIGNITURE **Traditional Facade** Garage to RH "2018 Design Range"

?? Client Full Name SITE ADDRESS: Lot ??? ?? Street


Site Plan DRAWN DD.MM.YY SCALE: 1:200 02 405??? ?? Suburb, QLD ??postcode

N2 WIND CATERGORY

NOTE: PROVIDE 300mm DEEP BULKHEAD OVER ALL HAMPERS

NOTE: PROVIDE 1 SHELF & HANGING RAIL TO ALL ROBES AND 4 SHELVES (equally spaced) FOR ALL LINEN CUPBOARDS



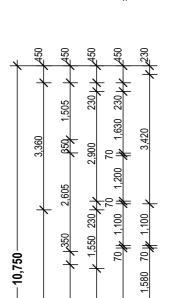

NOTE: PROVIDE SECURITY SCREENS TO **ALL OPENABLE WINDOWS &** SLIDING GLASS DOORS

PROVIDE FULL HT. MASONRY ARTICULATION AS PER ENGINEERS SOILTEST REPORT

COMMS. PREWIRED

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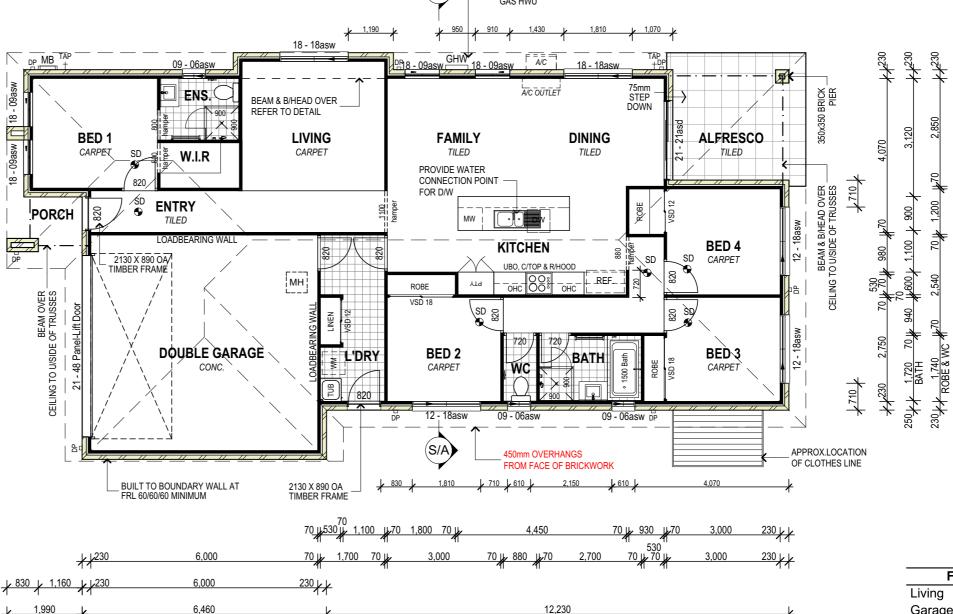
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DIMENSIONS TO BE READ IN PREFERENCE TO SCALING

3,770 7,390 (S/A WALL MOUNTED

20,680



Floor Areas Living 137.48 37.24 Garage Alfresco 12.01 20,680 3.72 Porch 190.45 m²



NOTE: **ALL WINDOWS &** EXTERNAL DOORS TO BE CENTERD IN WALL/ROOM UNLESS DIMENSIONED OTHERWISE


> NOTE: 450mm EAVE UNO


N2 WIND CATERGORY

NOTE: PROVIDE SECURITY SCREENS TO ALL OPENABLE WINDOWS & SLIDING GLASS DOORS

ENTRY DOOR NOTE: ENTRY DOOR STYLE SHOWN IS INDICATIVE ONLY. REFER TO THE CONTRACT FOR FURTHER DETAILS

> NOTE: 450mm EAVE UNO

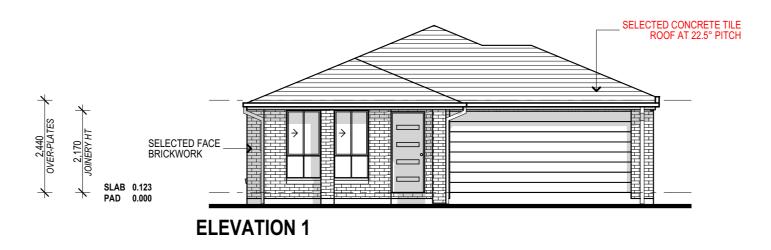

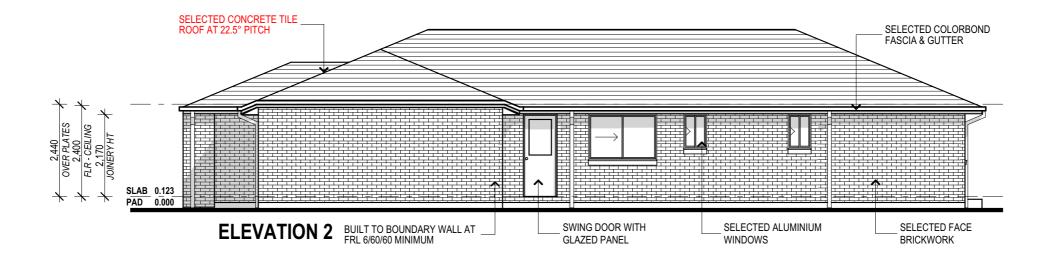

COMMS. PREWIRED

PROVIDE FULL HT. MASONRY ARTICULATION AS PER ENGINEERS SOILTEST REPORT



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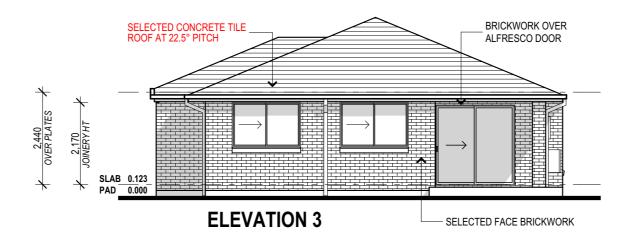
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t	CLIENT'S SIGNITURE: NOTES:	DATE:	Newtown 190 Traditional Facade	
			Garage to RH	
			"2018 Design Range"	


?? Client Full Name		Elevations		
SITE ADDRESS:	DRAWN:	DD.MM.YY	Rev:	
Lot ???	SCALE:	CHECKED:	Α	
	1:100	??		
?? Street ?? Suburb, QLD ??postcode	SHEET: 04	405???	?	

N2 WIND CATERGORY

NOTE: 450mm EAVE UNO

NOTE: PROVIDE SECURITY SCREENS TO ALL OPENABLE WINDOWS & SLIDING GLASS DOORS



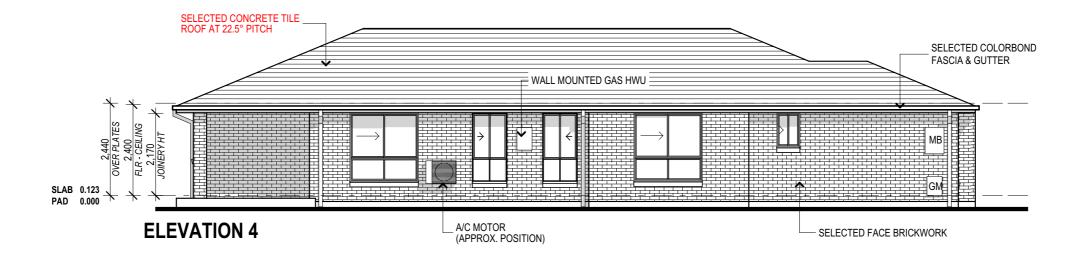

COMMS. PREWIRED

PROVIDE FULL HT. MASONRY ARTICULATION AS PER ENGINEERS SOILTEST REPORT





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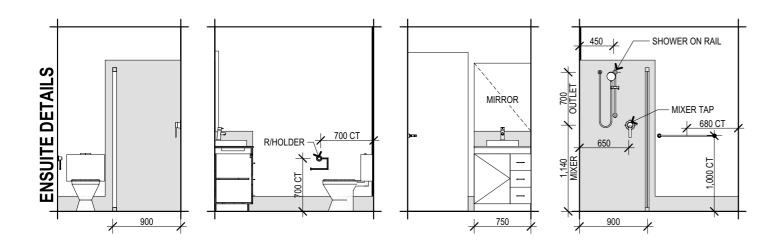
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t	NOTES:		Traditional Facade Garage to RH	
			"2018 Design Range"	


PRODUCT:


CLIENT: ?? Client Full Name	Elevations		
SITE ADDRESS:	DRAWN:	DATE: DD.MM.YY	Rev:
Lot ???	SCALE: 1:100	CHECKED: ??	Α
?? Street ?? Suburb, QLD ??postcode	SHEET: 05	JOB No: 405???	•



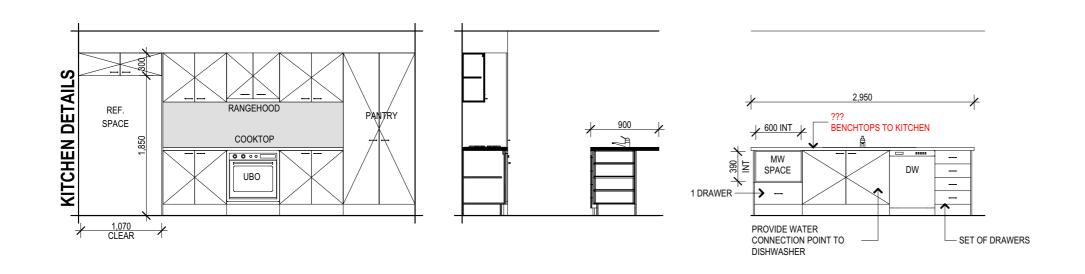

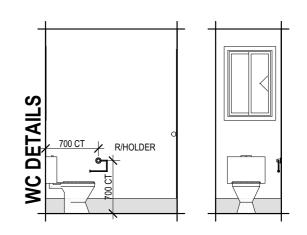

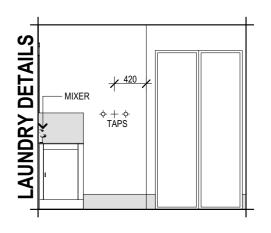

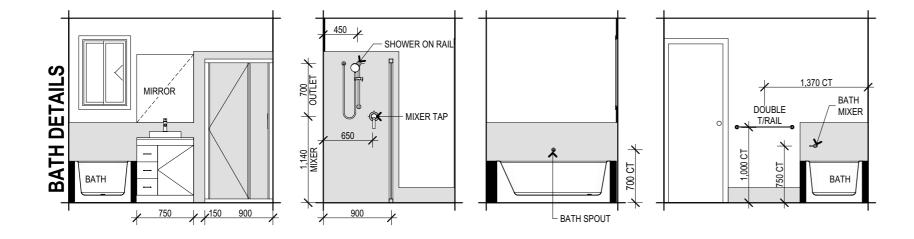

NOTE: ALL DIMENSIONS ARE FROM FLOOR LEVEL AND DO <u>NOT</u> INCLUDE BEDDING OR FLOOR TILES.

LIFT OFF HINGES TO COMPLY WITH BCA 3.8.3.3

CLEAR LAMINATED GLASS SHOWER SCREENS WITH POWDERCOATED ALUMINIUM FRAMES TO SHOWERS

ALL MIRRORS AT 900mm HIGH

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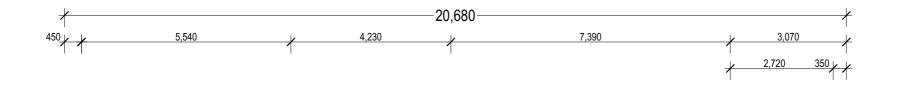
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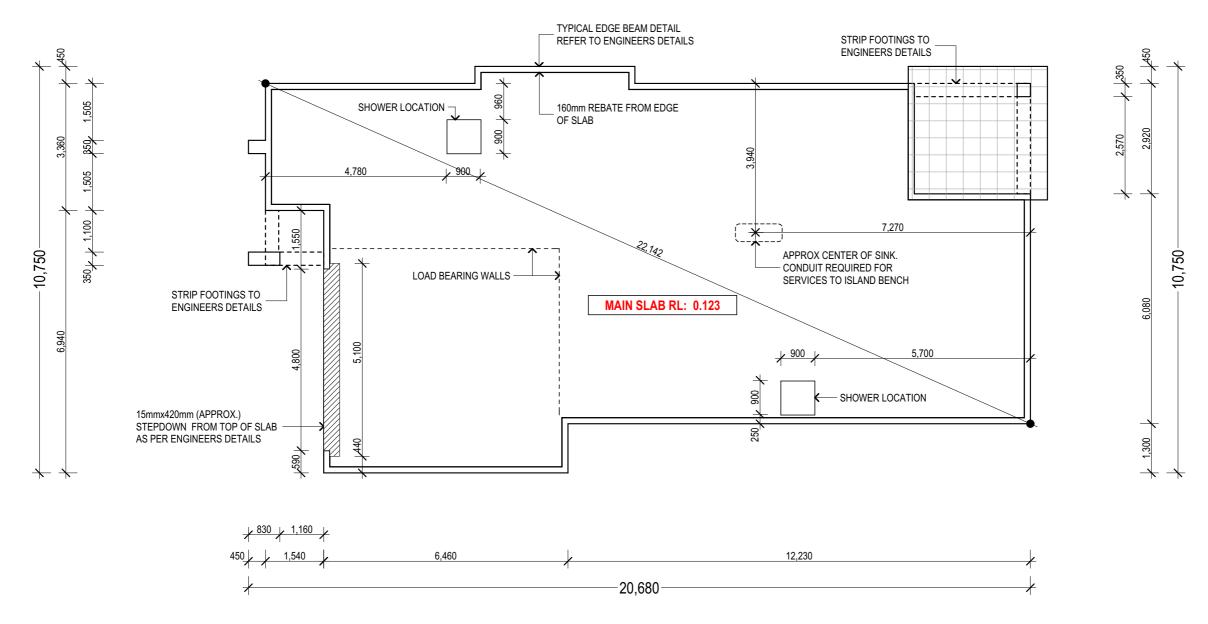
DIMENSIONS TO BE READ IN PREFERENCE TO SCALING

			PRODUCT:
	CLIENT'S SIGNITURE:	DATE:	New1
ht	NOTES:		Tradition
			Garage
			Junugu
			"2018

	TRODUCT.
_	Newtown 190
	Traditional Facade Garage to RH
	"2018 Design Range"

CLIENT: ?? Client Full Name	Internal Elevations		
	DRAWN:	DATE:	Rev:
SITE ADDRESS:		DD.MM.YY	▲ ا
_ot ???	SCALE:	CHECKED:	A
?? Street	1:50, 1:100	??	
?? Suburb, QLD ??postcode	SHEET: 06	405???	?





NOTE: REFER TO ENGINEERS DESIGN FOR FOOTING & SLAB DETAILS

NOTE: PROVIDE TERMITE BARRIER AS PER A.S. 3660.1-2000

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NOTES:

Newtown 190 CLIENT'S SIGNITURE: **Traditional Facade** Garage to RH

"2018 Design Range"

Slab Plan ?? Client Full Name DD.MM.YY SITE ADDRESS: SCALE: Lot ??? CHECKED 1:100 ?? Street SHEET ຶ405??? 07 ?? Suburb, QLD ??postcode

ELECTRICAL LEGEND CODE TYPE SINGLE POWER POINT (GPO) DOUBLE POWER POINT (GPO) 0 DOWNLIGHT - LED LIGHT POINT - BAYONET **\$** LIGHT POINT - PENDANT (CF) LIGHT POINT - CIRCULAR FLURO LIGHT POINT - SINGLE FLURO LIGHT POINT - PARA FLOOD Φ-PHONE POINT \triangleright DATA POINT +++ TV POINT \boxtimes CEILING EXHAUST FAN 2 HEATER LIGHT FAN - 2 4 HEATER LIGHT FAN - 4 • SMOKE DETECTOR CEILING FAN CEILING FAN & LIGHT F FOXTEL POINT \bigcirc SKYLIGHT - LIGHT TUBE - LIGHT SWITCHES AT 1350mm ABOVE AFL

SMOKE DETECTORS APPROX. POSITION - INSTALLED AS PER

B.C.A. 3.7.2 & COMPLY WITH A.S.3786

- WALL MOUNTED LIGHTS AT 2000 ABOVE FL

1800 - RANGEHOOD (RH) 750 - MICROWAVE u/bench 1500 - REFRIGERATOR (REF) 1000 - VANITIES

1500 - WASHING MACHINE

- POWER OUTLETS AT 300mm ABOVE FL (EXCEPT FOR THE FOLLOWING)

1000 - KITCHEN BENCH

EXHAUST FANS TO COMPLY WITH A.S.1668.2. INSTALLED AS PER B.C.A. 3.8.5

Comms Box Connection Includes:

- * Lead in Cabling
- * Wiring Cabinet
- Gpo Near Wiring Cabinet
- * Lead in Conduit

All Above Items to Fibre Network Suppliers Specification


Fibre Network Supplier to Provide:

*Network Terminal Device

* PSU (Batery Back-Up by Home Owner)

COMMS. PREWIRED

POSITION OF ELECTRICAL POINTS SUBJECT TO CONSTRUCTION CONSTRAINTS

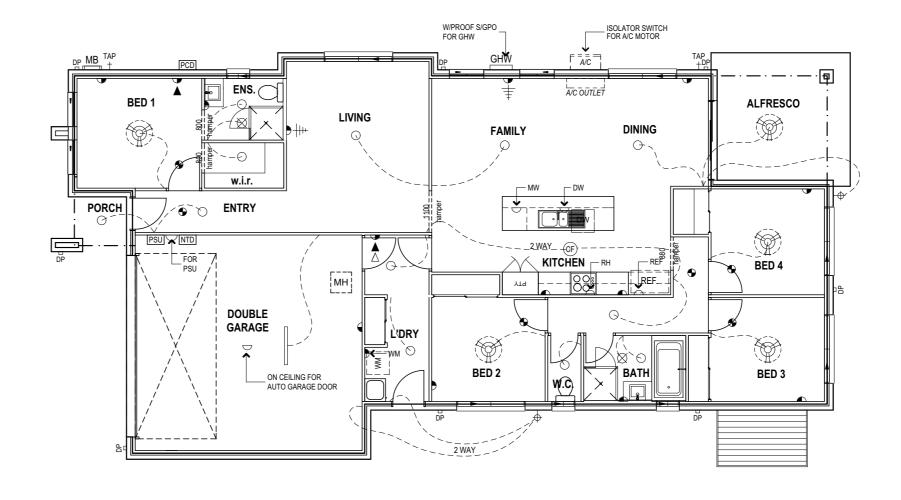

"2018 Design Range"



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DIMENSIONS TO BE READ IN PREFERENCE TO SCALING

SIGNITURE:	DATE:	PRODUCT: Newtown 190
		Traditional Facade Garage to RH

?? Client Full Name	Electrical Plan			
	DRAWN:	DATE:	Rev:	
SITE ADDRESS:		DD.MM.YY		
Lot ???	SCALE: 1:100	CHECKED:	Α	
?? Street	SHEET:	JOB No:		
?? Suburb, QLD ??postcode	08	405???	•	

N2 WIND CATERGORY Timber Brick pier / Brickwork Alfresco Bulkhead Detail


PREFABRICATED ROOF TRUSSES SPACED SELECTED CONCRETE TILE ROOF AT 22.5° PITCH AT 600mm MAX. CRS. DESIGNED & FIXED TO MANUFACTURERS SPECIFICATIONS SELECTED COLORBOND 450 NOM. EAVES FASCIA & GUTTER 2,400 FLR - CEILING 2,440 OVER PLATES FAMILY/DINING KITCHEN BED. 2 GROUND FLOOR: EXTERNAL & LOADBEARING TIMBER STUD WALLS TO BE 70mm THICK @ 450 CTS & INTERNAL STUD WALLS TO BE 70mm THICK UNLESS NOTED OTHERWISE @ 600mm CTS. SLAB 0.123 PAD 0.000 NOTE: PROVIDE TERMITE SLAB TYPE AS PER ENGINEERS DESIGN BARRIER AS PER A.S. 3660.1-2000 10mm PLASTERBOARD INTERNAL WALL LININGS. NOTE: REFER TO ENGINEERS FOOTING DESIGN 10mm PLASTERBOARD CEILING LININGS. 6mm VILLABOARD TO WET AREA INTERNAL WALL LININGS. **SECTION A-A** REFER TO SOIL REPORT - ?? SITE CLASSIFICATION '??'

GUTTER AND DOWNPIPES TO COMPLY WITH NCC 2016 PART 3.5.2

OVERELOW MEAGURES TO OUTTERS TAKEN FROM NOS 2042 RART 2 F 2 4

OVERFLOW MEASURES TO GUTTERS TAKEN FROM NCC 2016 PART 3.5.2.4.				
RAINFALL DURATION INTENSITIES (TABLE 3.5.2.1) OVERFLOW VOLUME FOR CONTINUOUS MEASURE (L/s/m) (TABLE 3.5.2.3a)				
5 MINUTE DURATION RAINFALL INTENSITIES (100 YEARS)	DESIGN 5 MINUTE DURATION RAINFALL INTENSITIES (100 YEARS)	RIDGE TO GUTTER LENGTH (MAXIMUM DEFAULT) (M)	OVERFLOW VOLUME FOR CONTINUOUS MEASURE (L/s/m)	
LOCALITY (mm/h)	DESIGN (mm/h)	40.0	1.4 L/s/m required	
IPWICH 278 BRISBANE 305 VICTORIA PT 320	300 325 325	16.0	1.5 L/s/m provided (REFER TO TABLE 3.5.2.4)	

Table 3.5.2.4 ACCE	Table 3.5.2.4 ACCEPTABLE OVERFLOW MEASURES			
Table a. Acceptable co	ontinuous o	verflow measure		
Description	Overflow	Construction		
Controlled back gap with-	Capacity (L/s/m)			
(a) a permanent minimum 10 mm spacer installed between the gutter back and the fascia; and	1.5	Top of fascia 10 mm		
(b) one spacer per bracket, with the spacer not more than 50 mm wide; and		Spacer		
(c) the back of the gutter installed a minimum of 10 mm below the top of the fascia.				

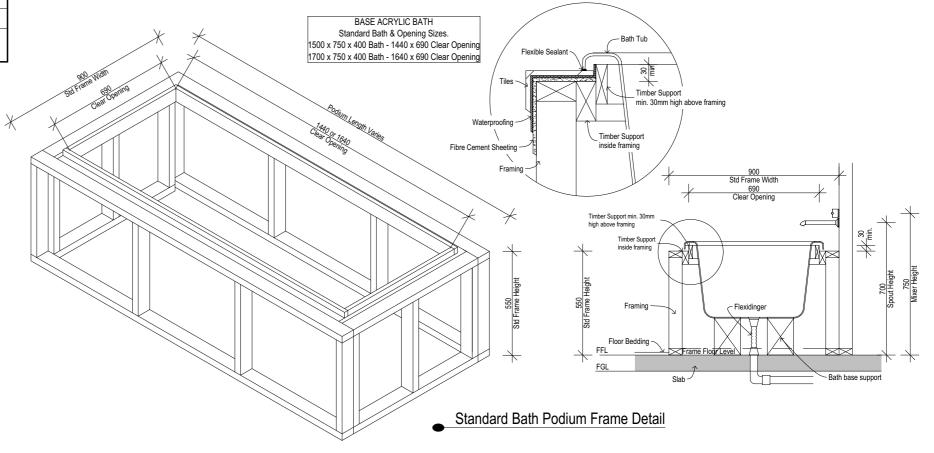




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Newtown 190 **Traditional Facade** Garage to RH

"2018 Design Range"

?? Client Full Name DRAWN: SITE ADDRESS: SCALE: Lot ??? 1:100, 1:20 ?? Street

Section AA DD.MM.YY 405??? 09 ?? Suburb, QLD ??postcode

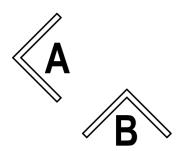

PROVIDE FULL HT. MASONRY ARTICULATION AS PER ENGINEERS SOILTEST REPORT

BRACING SCHEDULE


- UPPER OR SINGLE STOREY
- CONCRETE TILED ROOF
- JOINT GROUP = JD4

N2

	-30111 011001 - 304				
DIF	RECTION A 🗢	R	EQUIRED) kN =	19.7
CODE	TYPE	LENGTH	VALUE	No.	TOTAL
Α	F11 STRUCTURAL PLY BRACE @ 6.0 kN/m	500mm	3.0kN		
Α	F11 STRUCTURAL PLY BRACE @ 6.0 kN/m	600mm	3.6kN		
Α	F11 STRUCTURAL PLY BRACE @ 6.0 kN/m	900mm	5.4kN	4	21.6
В	STEEL ANGLE BRACE @ 1.5 kN/m	1800mm	2.7kN		
В	STEEL ANGLE BRACE @ 1.5 kN/m	2400mm	3.6kN		
В	STEEL ANGLE BRACE @ 1.5 kN/m	2700mm	4.0kN	2	8.0
С	BRACING BRICK PIER @ 1.5 kN (both direct	ions)	1.5kN		
	RESIS	STANCE P	ROVIDED	kN =	29.6
DIF	RECTION B	R	EQUIRED	kN =	41.4
CODE	TYPE	LENGTH	VALUE	No.	TOTAL
Α	F11 STRUCTURAL PLY BRACE @ 6.0 kN/m	500mm	3.0kN		
Α	F11 STRUCTURAL PLY BRACE @ 6.0 kN/m	600mm	3.6kN	4	14.4
Α	F11 STRUCTURAL PLY BRACE @ 6.0 kN/m	900mm	5.4kN	5	27.0
A B	F11 STRUCTURAL PLY BRACE @ 6.0 kN/m STEEL ANGLE BRACE @ 1.5 kN/m	900mm 1800mm	5.4kN 2.7kN	5	27.0
	-			5	27.0
В	STEEL ANGLE BRACE @ 1.5 kN/m	1800mm	2.7kN	3	27.0
B B	STEEL ANGLE BRACE @ 1.5 kN/m STEEL ANGLE BRACE @ 1.5 kN/m	1800mm 2400mm 2700mm	2.7kN 3.6kN		

TELESCOPIC SHS POST INSIDE ENGAGED/BRICK PIERS (TIED FROM FOOTINGS TO FRAMING MEMBERS) BRICK PIERS NOT CORE FILLED



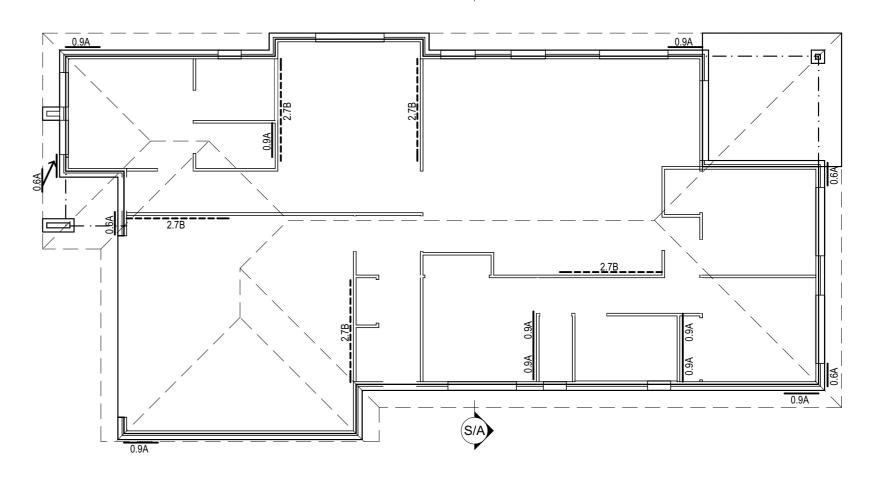

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PREFERENCE TO SCALING

. Bull	CLIENT'S SIGNITURE: DATE:	PRODUCT: Newtown 190
opyright d in Any ne, in ings.	NOTES:	Traditional Facade Garage to RH

CLIENT: ?? Client Full Name		Bracing Plan	
SITE ADDRESS:	DRAWN:	DATE: DD.MM.YY	Rev:
Lot ???	SCALE: 1:100	CHECKED: ??	┐ А
?? Street ?? Suburb. QLD ??postcode	SHEET:	JOB No: 405??	·?

SPECIFICATIONS:-

N.2 CONC. TILE ROOF SINGLE STORY

BY LAWS & CODES.

All construction shall be designed and built to comply with the Building Act 1975 and the Building Code of Australia 2010 edition & subsequent amendments to date & A.S 1684.2 2006 (residential timber framed construction)

MANUFACTURES SPECIFICATIONS.

Means a current specification approved by the Local Authority for use under the conditions applicable in this industry.

MATERIALS & COMPONENTS.


- 1. All Materials shall be new.
- Timber sizes and details not shown shall comply with A.S 1684.2
 All timber, truss sizes and details shall be as per A.S 1684.2 (2006)
- 3. Concrete ftg. 20MPa., remainder 20 MPa.
- 4. STEEL; Shop primed (all fixing bolts shall be hot dipped galvanised).
- 5. ROOFING; Selected Conc tile roofing fixed in accordance with manufacturers specifications.
- WALLS: Brick Veneer (wall ties @ 600 x 600) to comply with AS 3700 & Supp.1 SAA Masonary Code. Prefabricated wall frames - timber sizes shall comply with A.S 1684.2 (2006)
- WALL LINING: Plaster Board generally to all walls and ceilings (10mm thick to walls 10mm thick to ceiling) fixed
 in accordance with manufacturers specifications.
 6.0mm Villaboard to bathroom areas.
- 8. ALUMINIUM WINDOWS & DOORS: All windows and sliding glazed doors shall be powder coat finished (unless stated otherwise) fixed in strict accordance with manufacturers specifications all sizes shown on plan.
- 9. DOORS: Entry doors and timber frame shall be as per specifications. Where WC doors
- do not open outwards from WC room enclosure, they shall be provided with externally removable hinges.

 10. VENTILATION Intenal WC enclosures shall be vented in accordance with Part F4.5 or F4.6 of the Building Code of Australia.
- 10. VENTICATION Interial WC enclosures shall be vented in accordance with Part P4.5 of P4.5 of the building Code of Austral
- 11. D.P.C.: Provide approved damp proof course between bottom plates and concrete/masonry to all external walls and to all internal wet areas
- 12. FLASHINGS: All windows and sliding doors flush with gable ends shall have 50mm galvabond window flashing above.
- 13 EXTERNAL CLADDING: Refer to Elevations for details

TIE DOWN FIXINGS

330mm Battens spacings/roof tile setout and 600mm truss/rafter spacings (U.N.O)

- 1. Roofing fixed to battens in accordance to manufacturers specifications.
- Fixing of battens to rafters or trusses by 1/65mm x 2.8 dia grooved nail (40mm penetration into receiving member) (or approved fasteners).
- 3. Fixing of rafters or trusses to top plate by 1 framing achor with 3/2.8 dia. nails each leg.

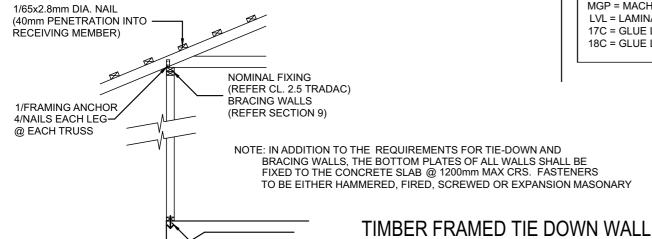

TIMBER SCHEDULE

REFER TO "FRAME & TRUSS SUPPLIER" SPECIFICATION/CERTIFICATION

NOTE: Unless stated otherwise on floor plan, seasoned timber sizes as per timber schedule below as per A.S 1684.2 (2006)

Bottom Plate 70 x 35 MGP 10

Top Plate 2/70 x 35 MPG 10 (roof span up to 8000)

2/70 x 35 MGP 12 (roof span up to 14000)

Nogging 70 x 35 MGP 10

Studs (loadbearing wall) @ 450 crs 70 x 35 MGP 10 - 2440mm High (roof span up to 14000) 70 x 35 MGP 12 - 2740mm High (roof span over 14000) 70 x 35 MGP 12 - 2440mm High (roof span over 14000)

Studs (non-loadbearing bracing wall) @ 450 crs - 70 x 35 MPG 10 up to 3000 - 70 x 35 MGP 12 up to 3600

Studs (side of openings)

Lintels - unless noted on floor plan, refer to "FRAME & TRUSS SUPPLIER" SPECIFICATION/CERTIFICATION

NOTE: Lintel/Roof beam sizes do not account for Girder trusses. Sizes may increase on site to cater for any extra loads or to the availability of timber sizes.

Refer to table below or Duncans, Hynes or Tasbeam load tables.

Roof Battens 50 x 25 F14 unseasoned hardwood

ROOF SPAN STUDS AT SIDE LINTELS 1400 1900 3600 120x35 MGP12 120x35 MGP10 190x35 MGP10 190x3 1800 2100 2400 2700 240x36 LVL 3000 240x45 LVL 260x65 17C 240x63 I VI 3300 240x63 LVL 3600 270x65 18C 260x65 17C 3900 295x65 17C 300x65 18C 360x65 18C 4 300x65 18C 330x65 18C 360x65 18C MGP = MACHINE GRADED PINE (TRADAC) LVL = LAMINATED VENEER LUMBER **TILLING TIMBER** JD4 17C = GLUE LAMINATED PINE BEAMSD2 JD1 HYNEBEAM 18C = GLUE LAMINATED HWD BEAMSD2 HYNEBEAM JD1

NOMINAL FIXINGS FOR TIMBER MEMBERS

TIEDOWN SCHEDULE N2 TILE ROOF (UPLIFT LOAD WIDTH 7500)


		,					
MEMBERS	UPLIFT	UPLIFT METHOD		KN PROVIDEDETAIL			
ROOF BATTEN TO RAFTER							
TRUSSES TO TOP PLATE @ 600 CTR	As per M	anufacturers requirements					
PLATES TO STUDS (upper floor or single storey)	Nominal	2/75mm nails through plate into end grain of stud top and bottom.	0.17kn				
LINTELS < 3.0	Nominal	2/75mm nails through lintel into stud					
LINTELS < 6.0	Nominal	2/75mm nails through lintel into stud					
BOTTOM PLATE TO CONCRETE (single storey)	Nominal	1 masonry nail (hand driven or fired) at not more than 1200mm crs	1.0.kn				
BOTTOM PLATE (upper floor) TO TOP PLATE (lower floor)	As per M	anufacturers requirements					
VERANDAH PLATE TO POST @ 3000 MAX CTRS (7500 U.L.W.)	Nominal	2/M10 cup head bolts	8.4kn				
PLATES TO STUDS (lower floor)	Nominal	2/75mm nails through plate into end grain of stud top and bottom.	0.17kn				
BOTTOM PLATE TO CONCRETE (lower floor)	Nominal	1 masonry nail (hand driven or fired) at not more than 1200mm crs	1.0.kn				
				<u> </u>			


NOTE:- PREFABRICATED FRAME SUPPLIER IS TO SUPPLY SCHEDULE & CERTIFICATION FOR FRAMES SUPPLIED.


DESIGNED IN ACCORDANCE WITH THE BUILDING CODE OF AUSTRALIA AND THE BUILDING ACT 1975.

		NAIL @ 1200 MAX. CRS							
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ROOF BRACING



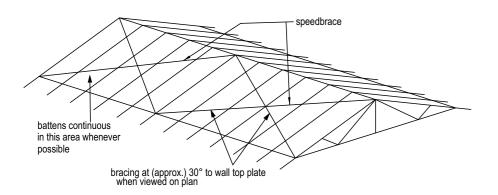

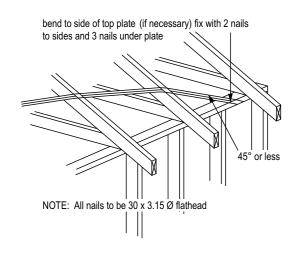

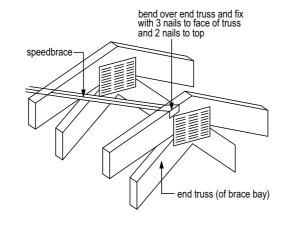WALL BRACING

Bracing to be located as shown on plan.
Structural ply to external walls (inside cavity) - refer to detail Bracing Type A.

All bracing shall be fixed in strict accordance to manufacturers specifications.

The top of all timber bracing walls shall be fixed to roof and ceiling - refer to details "C" and "D".

STRUCTURAL PLYWOOD - 6.0kN/m

F14, 4mm thick min. structural plywood on outer face of stud wall nailed to frame with 30 x 2.8mm dia flathead nails or equivalent. Studs @ 450 ctrs behind panels.

PLYWOOD BRACING PANELS- equal to or greater than 900mm lengths

Nailing ctrs: Top & Bottom plates - 50mm

Vertical edges - 150mm Intermediate studs - 300mm

Fixings: Top - Method A, B, C, or D per

900mm length

Bottom - 1/M12 Bolt each end &

@ 1200 ctrs max

PLYWOOD BRACING PANELS- less than 900mm ply lengths

Nailing ctrs: Top & bottom plates - 150mm

Vertical edges - 150mm Intermediate studs - 300mm Top - Method A, B, C or D per

900mm ply length Bottom - 1/M12 full height rod


each end.

Fixings:


kN values: 0.6m = x 3.6kN (reduced by 0.6)

0.7m = x 4.2kN (reduced by 0.7) 0.8m = x 4.8kN (reduced by 0.8)


BRACING TYPE 'A' structural plywood detail - 6.0kN/m

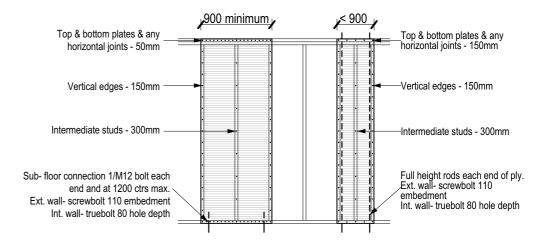



BRACING TYPE 'B' metal angle brace detail - 1.5kN/m

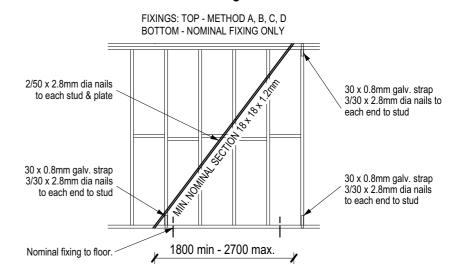


WALL BRACING UNDER SOFFIT DETAILS

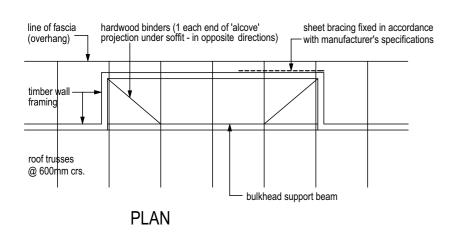

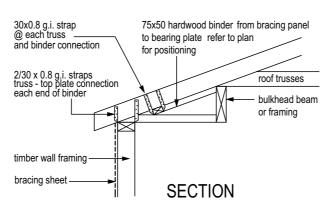

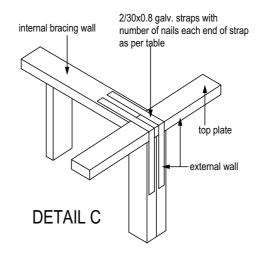

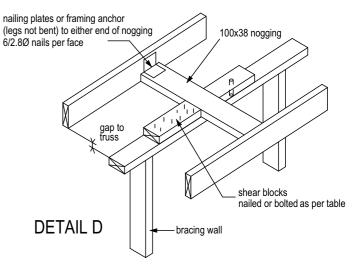

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1		www.gdevelopments.com.au
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